



KCB Buildings LLC
Keith Barnes, AIA, LEED AP – Registered Wisconsin Architect
P (WI): 608-669-4923
<a href="mailto:kcbbuildings.com">keith@kcbbuildings.com</a>

#### Statement of Intent

5025 N Hollywood – Whitefish Bay, WI – Second Story Addition over Existing Attached Garage

The single-family residence located at 5025 N Hollywood Ave is an existing 2-story home with a 2-car attached garage. The site is predominantly a flat site and the lot is an interior lot on the west side of N Hollywood Ave between E Lancaster Ave (to the North) and E Fairmount Ave (to the South). The proposed project includes a second-story addition over the existing attached garage which includes two additional bedrooms and one additional bathroom. The existing roof ridge height will not be exceeded by the addition.

Keith C. Barnes, AIA, LEED AP

Architect, Owner KCB Buildings LLC P (WI): 608-669-4923

## M.S.S. / MORTGAGE SURVEY SERVICE

6617 West Coldspring Road

Greenfield, Wisconsin 53220


(414) 327-4400

Lakeview Remodeling, LLC Prepared For

Location of Property 5025 North Hollywood Avenue, Whitefish Bay, WI

#### **Description of Property**

The South 60.00 ft of the North 60.25 feet of Lot 7, in Block 4, in ASSESSOR'S PLAT NO. 246, being a part of the Southwest ¼ of Section 33, Township 8 North, Range 22 East, in the Village of Whitefish Bay, Milwaukee County, Wisconsin.

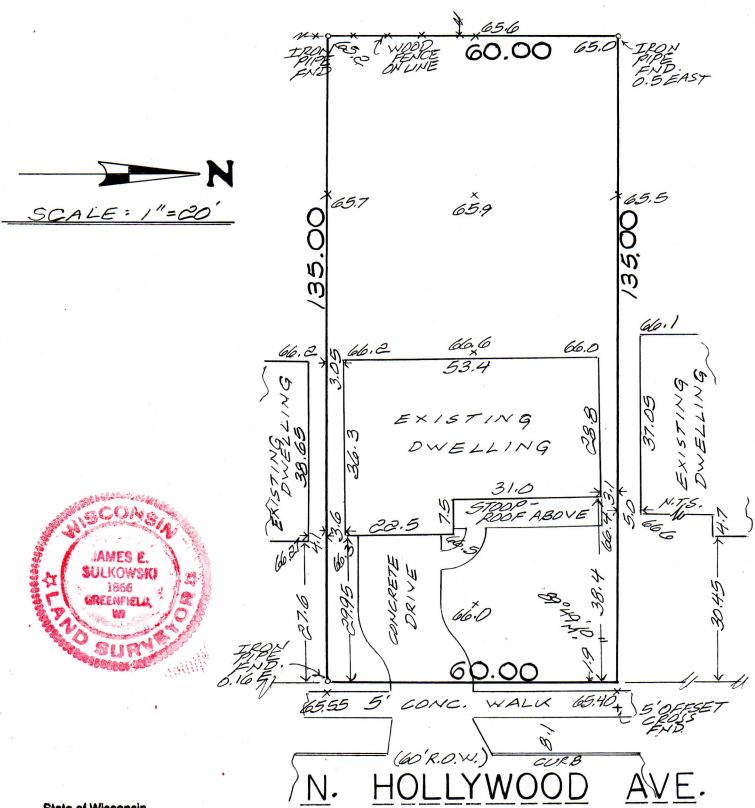

#### State of Wisconsin

I have surveyed the above-described property and the above map is a true representation thereof and shows the size and location of the property, its exterior boundaries, the location and dimensions of all structures thereon, fences, apparent easements and roadways and visible encroachments, if any.

This survey is made for the exclusive use of the present owner of the property, and also those who purchase, mortgage, or guarantee the title thereto within (1) year from date hereof.

26<sup>th</sup>

day of

Dated at NOTE: All property corners will not be located, verified and/or reset (per Section A-E7.01 Wisconsin Administrative Code) unless specifically requested.


Greenfield, WI


Registered Land Surveyor


2022

April

## RESIDENTIAL SECOND STORY ADDITION

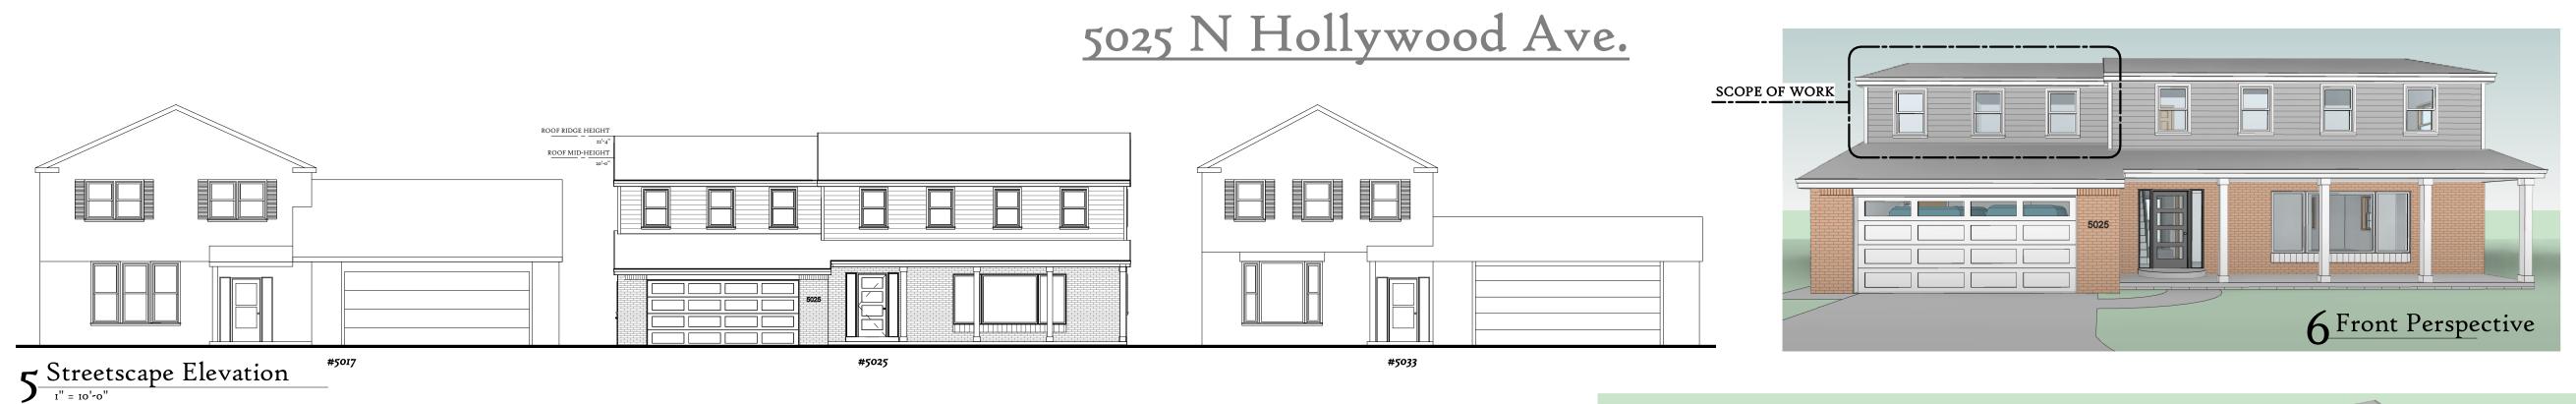

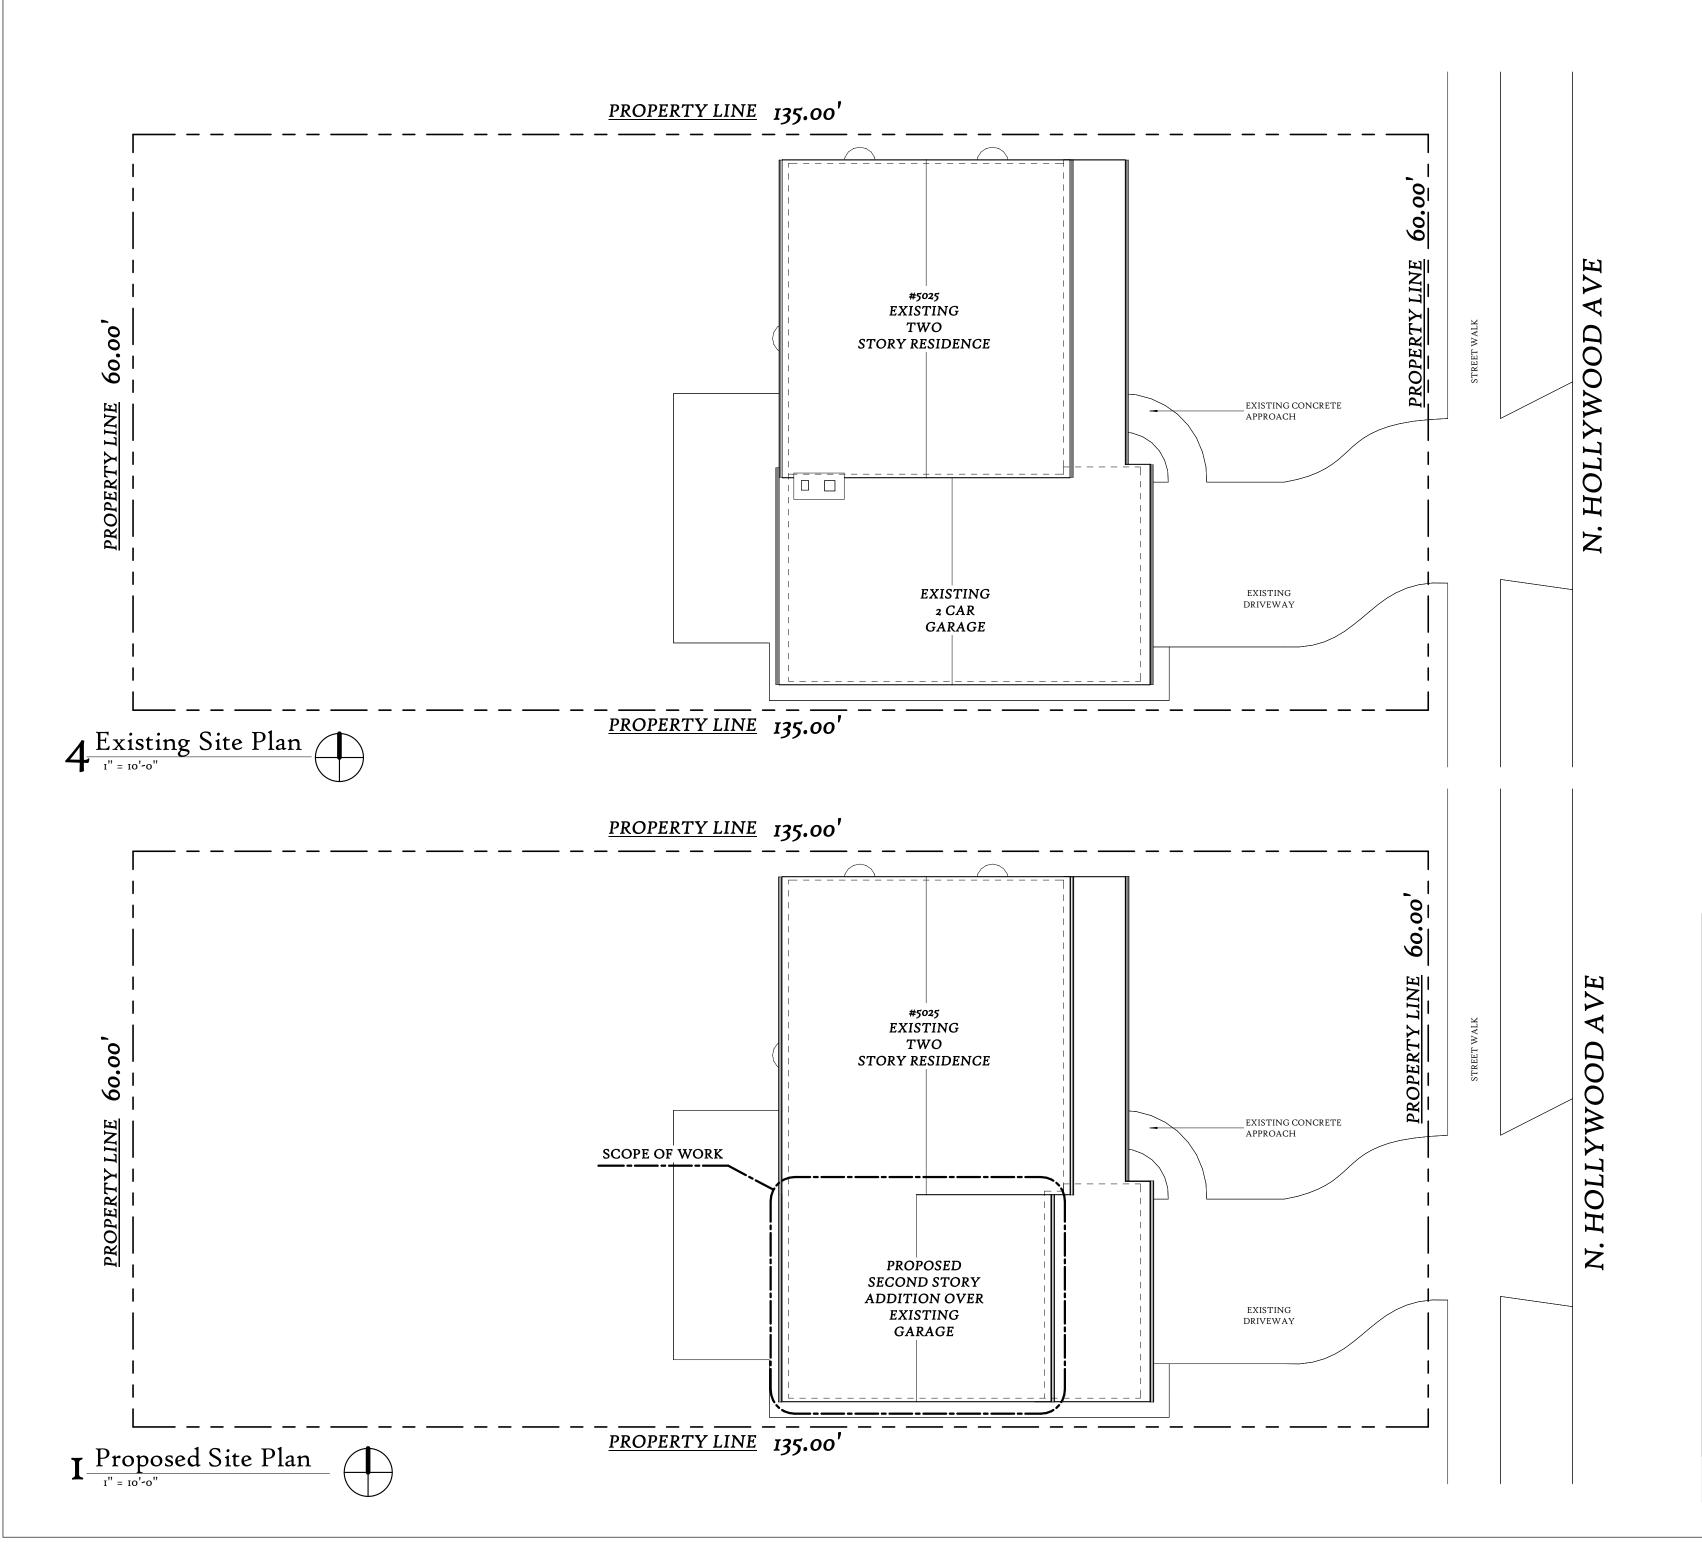

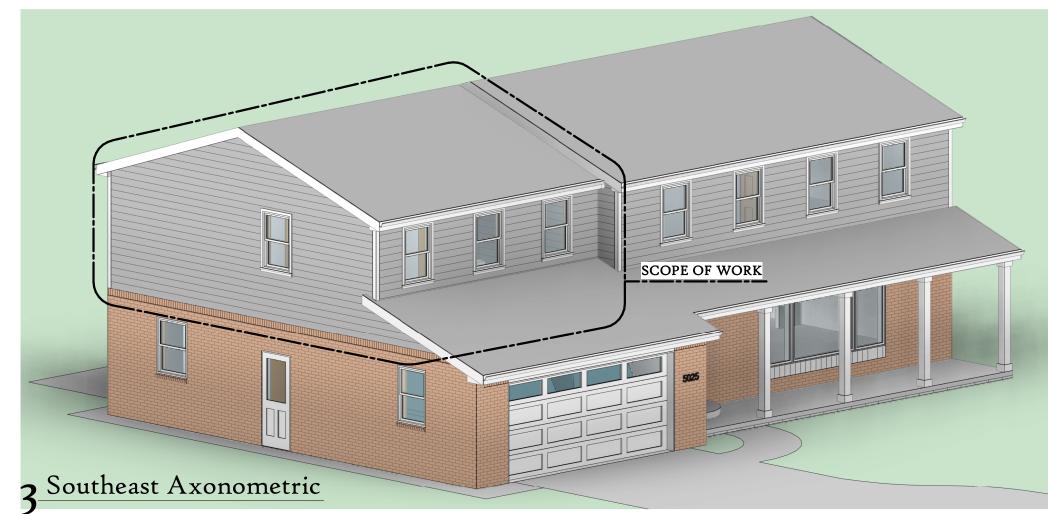





**EXISTING CONDITION PHOTOGRAPH** 

**EXISTING CONDITION PHOTOGRAPH** 



## **DRAWING INDEX**

DRAWING INDEX	
Sheet Number	Sheet Name
A-001	Cover Sheet & Site Information
A-101	First & Second Floor Plans
A-102	Basement Plan & Roof Plan
A-201	Exterior Elevations

### ZONING INFO:

1. Lot Area: 8100 sf

2. Zoning District: 2, Single Family Residential District

3. Required Minimum Setbacks: Front: 30' (mapped)

Rear: 10' (3' for garage)





PROJECT:

## 5025 N Hollywood - Second Story Addition

Bryan & Christine Schultz

PROJECT ADDRESS: 5025 N Hollywood Ave

**CONTRACTOR:** 

LAKEVIEW REMODELING, LLC

MIKE DINDORF 414-708-9528

lakeviewremodel@gmail.com

KCB BUILDINGS

ARCHITECT:

KEITH BARNES, AIA 608-669-4923 keith@kcbbuildings.com


Drawing Issuance Schedule:

No. Description		Date	
I	ARC Submittal	Date 5/2/2022	

Contractor to field verify all dimensions, levels and datums prior to starting the work. Any discrepancies or omissions shall be reported to the General Contractor and/or

All work shall be done in compliance with local codes, ordinances, rules and regulations.

No work shall be started until plans have been approved by the building inspector and all other agencies having

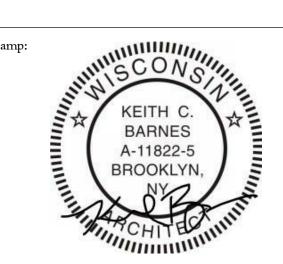

## Cover Sheet & Site Information

Scale	I" = IO'-O"
Date	5/2/2022

A-ooi



#### **FLOOR PLAN LEGEND**

EXISTING WALL TO REMAIN

IN LEGEND

NEW WALL

LAKEVÂEW REMODELING, LLC.



PROJECT:

## 5025 N Hollywood - Second Story Addition

OWNER:

Bryan & Christine Schultz

PROJECT ADDRESS:

5025 N Hollywood Ave

CONTRACTOR:

LAKEVIEW REMODELING, LLC CONTACT:

MIKE DINDORF 414-708-9528 lakeviewremodel@gmail.com

ARCHITECT:
KCB BUILDINGS

CONTACT:

KEITH BARNES, AIA 608-669-4923

keith@kcbbuildings.com

Drawing Issuance Schedule:


No.	Description	Date
I	ARC Submittal	5/2/2022

### General Notes:

Contractor to field verify all dimensions, levels and datums prior to starting the work. Any discrepancies or omissions shall be reported to the General Contractor and/or Architect.

All work shall be done in compliance with local codes, ordinances, rules and regulations.

No work shall be started until plans have been approved by the building inspector and all other agencies having jurisdiction.

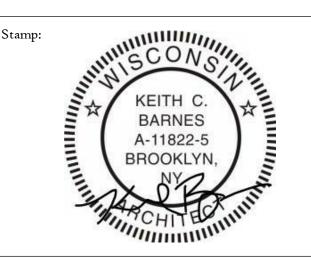

Sheet Title:


## First & Second Floor Plans

Scale	1/4" = 1'-0
Date	5/2/202

Sheet No.

A-ioi

5/2/2022 7:27:03 AM

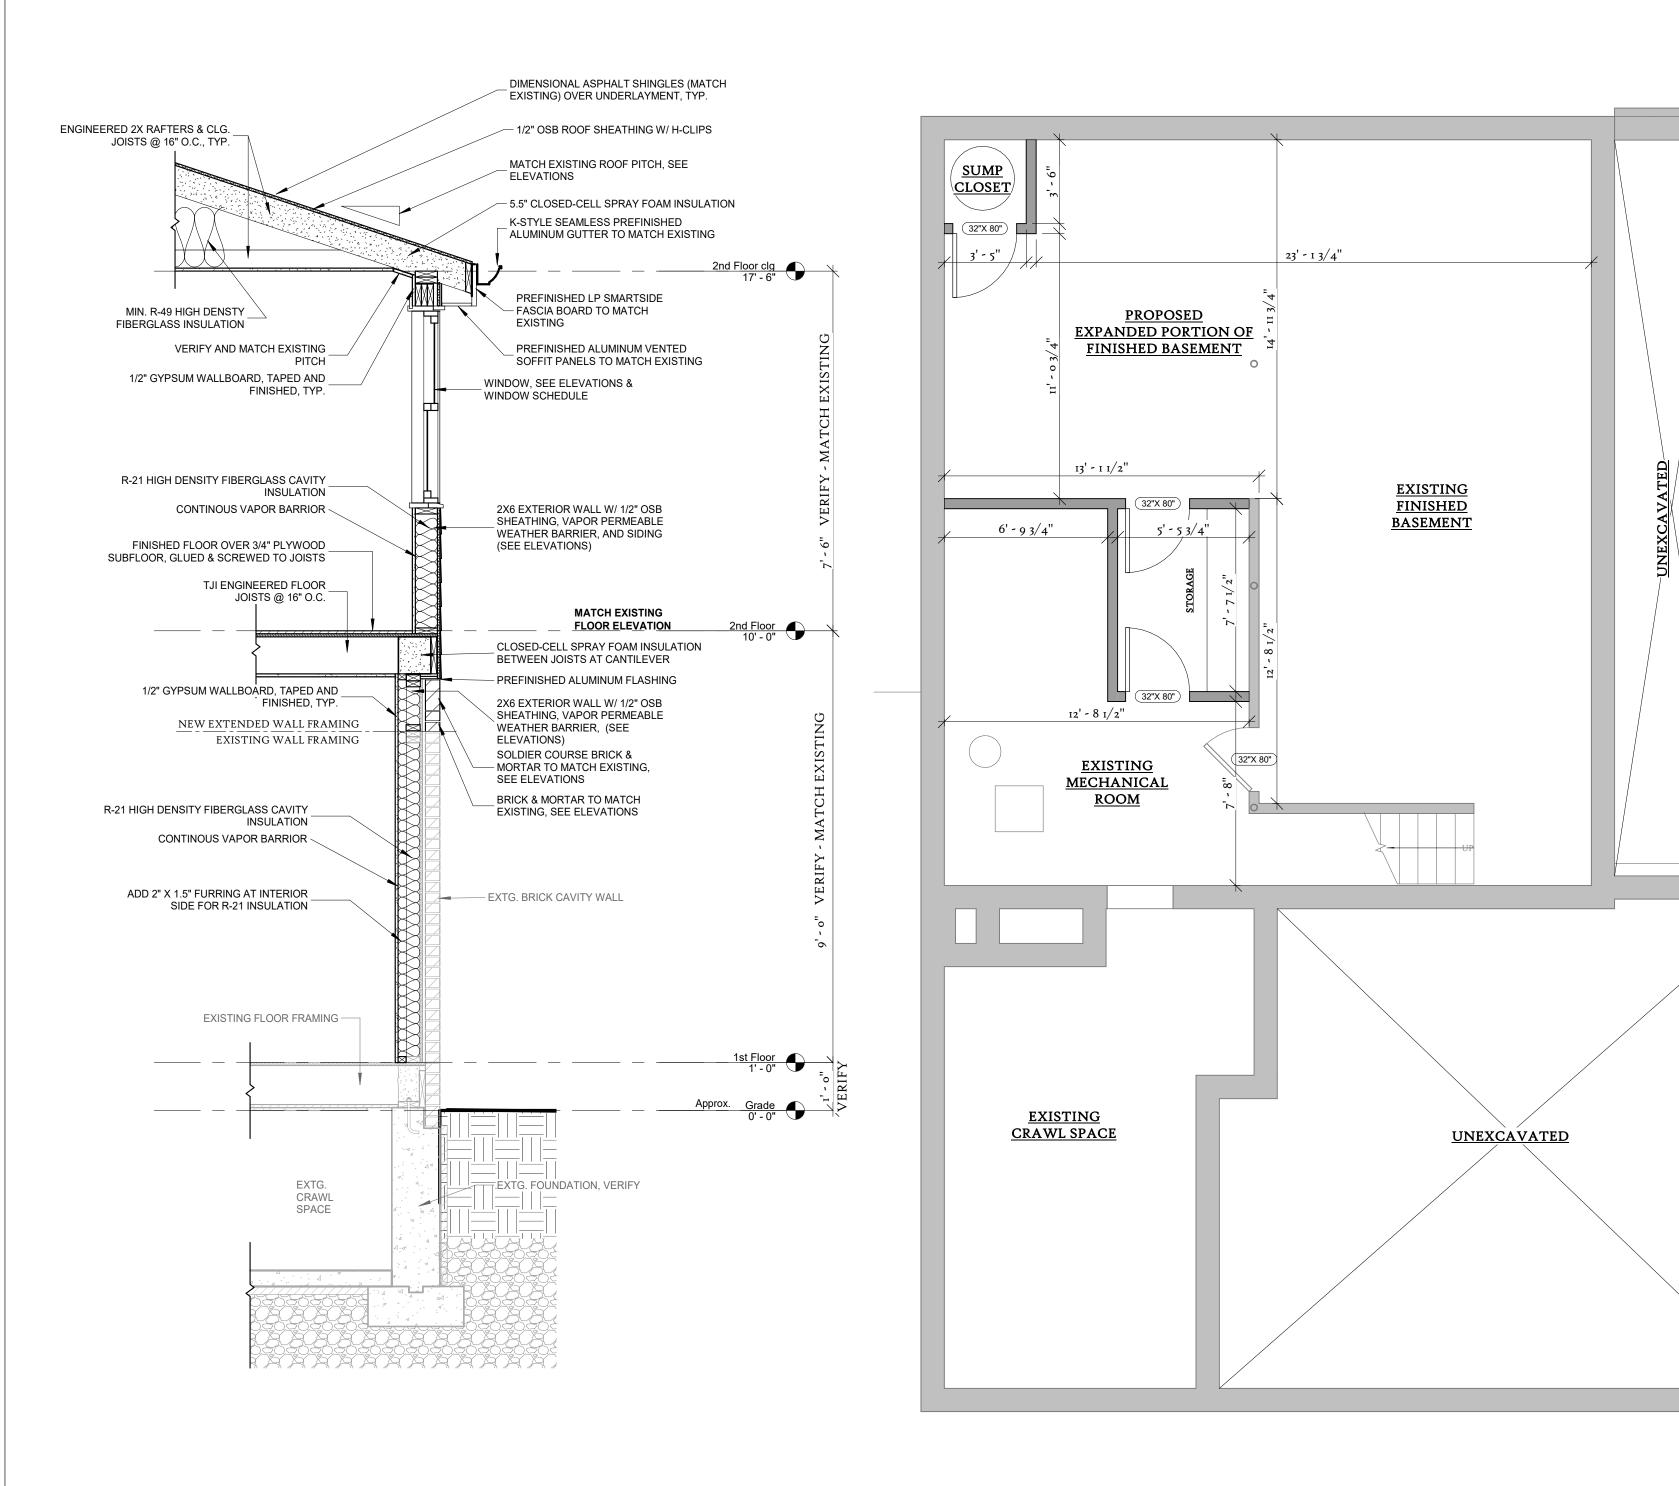

8" MATCH EXISTING DIMENSIONAL ASPHALT SHINGLE ROOFING TO MATCH EXISTING DIMENSIONAL ASPHALT SHINGLE ROOFING TO MATCH EXISTING 8" MATCH EXISTING PREFINISHED ALUMINUM GUTTER, Roof Plan

I/4" = I'-o"

3 WALL SECTION @ REAR

I Basement Floor Plan





PROJECT:

## 5025 N Hollywood - Second Story Addition

OWNER:

Bryan & Christine Schultz

PROJECT ADDRESS:

5025 N Hollywood Ave

CONTRACTOR:

LAKEVIEW REMODELING, LLC CONTACT:

MIKE DINDORF 414-708-9528

lakeviewremodel@gmail.com
ARCHI<u>TECT:</u>

KCB BUILDINGS

CONTACT:

KEITH BARNES, AIA 608-669-4923 keith@kcbbuildings.com

Drawing Issuance Schedule:


Description	Date	
ARC Submittal	5/2/2022	

#### General Notes:

Contractor to field verify all dimensions, levels and datums prior to starting the work. Any discrepancies or omissions shall be reported to the General Contractor and/or

All work shall be done in compliance with local codes, ordinances, rules and regulations.

No work shall be started until plans have been approved by the building inspector and all other agencies having jurisdiction.

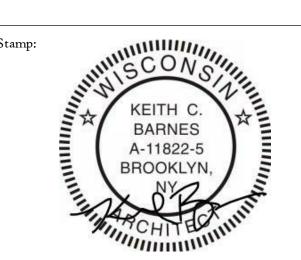

Sheet Title:

# Basement Plan & Roof Plan

 Scale
 As indicated

 Date
 5/2/2022


Sheet No.

A-102





#### MILWAUKEE COUNTY INTERACTIVE MAPPING SERVICE

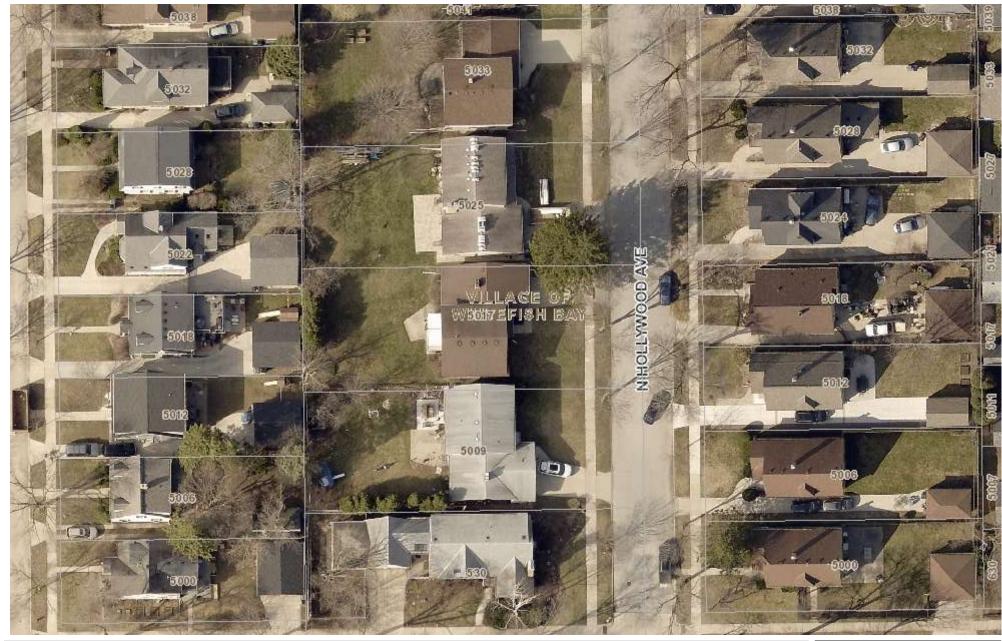

94 0 47 94 Feet

NAD\_1983\_2011\_StatePlane\_Wisconsin\_South\_FIPS\_4803\_Ft\_ 1: 564

DISCLAIMER: This map is a user generated static output from the Milwaukee County Land Information Office Interactive Mapping Service website. The contents herein are for reference purposes only and may or may not be accurate, current or otherwise reliable. No liability is assumed for the data delineated herein either expressed or implied by Milwaukee County or its employees.

Notes

THIS MAP IS NOT TO BE USED FOR NAVIGATION

## **Design Area Information Worksheet**

Address_		5025 N	Hollyw	/ood		
Heig	<b>yht</b> To Peak	Existing	22.7'	Proposed	22.7'	No change proposed
	To Mid Span	Existing	19.8'	Proposed	19.8'	No change proposed
	To Eave	Existing_	16.9'	Proposed	16.9'	_ No change proposed
Setb	acks					_
	Front	Existing_	29.95'	Proposed	29.95'	No change proposed
	Right Side	Existing_	3.1'	_ Proposed	3.1'	No change proposed
	Left Side	Existing_	3.05'	_ Proposed	3.05'	No change proposed
	Rear	Existing_	67.0'	_ Proposed	67.0'	No change proposed
Stru	cture Information					
	First Floor Sq. Ft.	Existing	1232 sf	Proposed	1262 sf	
	Second Floor Sq. Ft.	Existing_	928 sf	Proposed	1504 sf	
	<b>Covered Porches</b>	Existing_	0 sf	Proposed_	0 sf	
	<b>Enclosed Porches</b>	Existing_	0 sf	_ Proposed	0 sf	_
	Accessory Bldgs	Existing_	510 sf	_ Proposed	480 sf	_
Lot S	Size (sq ft)	8,10	0 sf			

Please provide the address and Floor Area Ratio for each home in the Design Area

26.7%

Proposed

34.1%

	FAR of Design Area	Lot (sf)	Bldg (sf)	FAR
1	5028 N DIVERSEY BLVD	4800	1860	38.8
2	5022 N DIVERSEY BLVD	4800	1628	33.9
3	5009 N HOLLYWOOD	8100	2040	25.2
4	5017 N HOLLYWOOD	8100	2040	25.2
5	5033 N HOLLYWOOD	8100	1979	24.4
6	5041 N HOLLYWOOD	8100	1905	23.5
7	5047 N HOLLYWOOD	5805	1378	23.7
8	5053 N HOLLYWOOD	5400	1783	33.0
9	5059 N HOLLYWOOD	5400	1558	28.9
10	5070 N HOLLYWOOD	5400	1338	24.8
- 4	D is sale to the first of the first	CI	C.1 1 010 1 11	

Existing

Floor Area Ratio

F.A.R. is calculated by dividing the total, or gross, floor area of the building by the gross area of the lot. Enclosed porches should be included in the gross floor area. Garages (attached or detached) should not be included in the F.A.R. calculation.

## **Design Area Information Worksheet**

11	FAR of Design Area	Lot (sf)	Bldg (sf)	FAR
:11	5064 N HOLLYWOOD	5400	1610	29.8
:12	5060 N HOLLYWOOD	5670	1519	26.8
:13	5054 N HOLLYWOOD	5400	1660	30.7
14	5048 N HOLLYWOOD	4860	2492	51.3
:15	5044 N HOLLYWOOD	4860	1914	39.4
:16	5038 N HOLLYWOOD	4860	1813	37.3
<sub>:</sub> 17	5032 N HOLLYWOOD	5400	1542	28.6
18	5028 N HOLLYWOOD	5400	1783	33.0
;19	5024 N HOLLYWOOD	5400	1741	32.2

21.

22.

23.

24.

25.

26.

27.

28.

29.

30.

31.

32.

33.

34.

35.

36.

37.

38.

39.

40.

F.A.R. is calculated by dividing the total, or gross, floor area of the building by the gross area of the lot. Enclosed porches should be included in the gross floor area. Garages (attached or detached) should not be included in the F.A.R. calculation.







**NORTH SIDE PHOTO** 

FRONT SIDE PHOTO



**SOUTH SIDE PHOTO** 



**REAR PHOTO** 



5025 N. Hollywood Blvd - SUBJECT PROPERTY

DESIGN AREA PHOTOGRAPHS

5025 N. Hollywood Blvd.

Project Address:
5025 N. Hollywood Blvd

SK-000

Keith C. Barnes, AIA, LEED AP



5006 N. Hollywood



5018 N. Hollywood



5012 N. Hollywood



5024 N. Hollywood





5028 N. Hollywood



5038 N. Hollywood



5032 N. Hollywood



5044 N. Hollywood



Keith C. Barnes, AIA, LEED AP
Registered Architect [ New York, Wisconsin ]
e: keith@kcbbuildings.com p: (608) 669-4923

5025 N. Hollywood Blvd.

Project Address:
5025 N. Hollywood Blvd

SK-000 Scale:



5048 N. Hollywood



5060 N. Hollywood



5054 N. Hollywood



5064 N. Hollywood





5070 N. Hollywood



5053 N. Hollywood



5059 N. Hollywood



5047 N. Hollywood



Registered Architect [ New York, Wisconsin ]

e: keith@kcbbuildings.com p: (608) 669-4923

DESIGN AREA PHOTOGRAPHS

5025 N. Hollywood Blvd.

Project Address:
5025 N. Hollywood Blvd.

Scale:

SK-ooo



5041 N. Hollywood



5017 N. Hollywood



5033 N. Hollywood



5009 N. Hollywood



Registered Architect [ New York, Wisconsin ]

e: keith@kcbbuildings.com p: (608) 669-4923

DESIGN AREA PHOTOGRAPHS

5025 N. Hollywood Blvd.

Project Address:
5025 N. Hollywood Blvd.

SK-000 Scale:



5028 N. Diversey



5022 N. Diversey

